	PREMISE DISTRIBUTION SYSTEM (PDS)	SYMBOL LEGEND		
SYMBOL	DESCRIPTION	MOUNTING HEIGHT	MOUNTING	CABLING
▼ 2P	COMMUNICATIONS OUTLET WITH MINIMUM 1"C. EXTENDED ABOVE CEILING AND TURNED INTO ROOM IT SERVES. (2) COMMUNICATIONS PORTS AND (4) BLANKS. WIRED COMPLETE.	18" A.F.F. UNLESS OTHERHWISE NOTED	FLUSH IN WALL	TWO (2) CAT 6 CABLES
2P + P	COMMUNICATIONS OUTLET WITH MINIMUM 1"C. EXTENDED ABOVE CEILING AND TURNED INTO ROOM IT SERVES. (2) COMMUNICATIONS PORTS AND (4) BLANKS. (2) CAT6 PLUS F/UTP TO AV-01, (1) HDMI (1) CAT6 RS 232.	18" A.F.F. UNLESS OTHERHWISE NOTED	ABOVE CEILING	TWO (2) CAT 6 CABLES
▼ 4P + AV2	COMMUNICATIONS OUTLET WITH MINIMUM 1"C. (4) COMMUNICATIONS PORTS AND (2) BLANKS. (2) CAT6 + F/UTP TO LOCAL AV-01, (2) HDMI TO AV-01, (1) VGA TO AV-01.	18" A.F.F. UNLESS OTHERWISE NOTED	FLUSH IN WALL	TWO (4) CAT 6 CABLES
(*)	COMMUNICATIONS OUTLET MOUNTED IN FLOOR BOX SEE GENERAL SYMBOL LEGEND. SEE SPECIFIC OUTLET SYMBOL FOR JACK AND WIRING REQUIREMENTS	FLOOR	FLUSH	
IDF(MDF)	INTERMEDIATE DISTRIBUTION FRAME (MAIN DISTRIBUTION FRAME) CABINET		FREESTANDING	
/PDS\	PREMISES DISTRIBUTION SYSTEM CABLE IN RACEWAY OR J-HOOKS (UNLESS SPECIFICALLY OTHERWISE NOTED). CONCEALED.	CONCEALED	CONCEALED	
	RACEWAY INTERCEPTION POINT (TYPICAL)	CONCEALED	CONCEALED	

* - DESIGNATOR INDICATES TYPE OF COMMUNICATION OUTLET.

PDS SYSTEM GENERAL NOTES

1) REFER TO SPECIFICATIONS.

2) REFER TO SPECIFICATIONS FOR BASIS OF DESIGN.

3) REFER TO DETAILS.

4) ELECTRICAL CONTRACTOR TO PROVIDE AND INSTALL PULL STRINGS IN ALL EMPTY RACEWAYS/CONDUITS.

5) LOCATION OF ALL DEVICES ON PLANS ARE APPROXIMATE ONLY. VERIFY EXACT LOCATIONS, HEIGHTS, ETC. WITH OWNER AND/OR ARCHITECT PRIOR TO ROUGH-IN.

6) COORDINATE EXACT INSTALLATION REQUIREMENTS OF OUTLETS IN MILLWORK WITH ARCHITECTURAL DRAWINGS AND APPROVED MILLWORK SHOP DRAWINGS.

7) PROVIDE FIRE STOPPING ON ALL CONDUITS [AND SLEEVES] PENETRATING A RATED WALL OR FLOOR.

8) ALL [CABLES] [AND] [RACEWAYS] TO BE CONCEALED UNLESS SPECIFICALLY NOTED OTHERWISE OR APPROVED BY ENGINEER. SEE SPECIFICATIONS AND GENERAL NOTES FOR ADDITIONAL CLARIFICATIONS.

9) ALL RACEWAY TERMINATIONS SHALL HAVE BUSHINGS AND BE GROUNDED WHERE RACEWAY IS METAL.

10) PROVIDE SYSTEM COMPLETE WITH ALL DEVICES, CABLES, PATHWAYS (RACEWAYS, CONDUITS, [SLEEVES], ETC).

11) ALL SYSTEM CABLES/WIRING MAY BE RUN IN ACCESSIBLE CEILING SPACES UTILIZING CABLE SUPPORTS AND SLEEVES FOR WALL PENETRATIONS IF CABLE/WIRING IS RATED FOR USE IN RESPECTIVE CEILING SPACE (PLENUM, ETC.) AND INSTALLED PER APPLICABLE STANDARDS/CODES. CABLE/WIRING MUST BE INSTALLED IN RACEWAY/CONDUIT WHERE INSTALLED IN

12) MINIMUM RACEWAY/CONDUIT SIZE TO BE 1".

NON-ACCESSIBLE SPACES.

13) ALL COMMUNICATION WALL OUTLETS AND FLOOR OUTLETS SHALL HAVE A 1" MINIMUM CONDUIT STUBBED UP AND OUT INTO ACCESSIBLE CEILING SPACE (OF ROOM OUTLET SERVES) UNLESS SHOWN OTHERWISE ON DRAWINGS.

14) CIRCUIT ALL DEVICES TO LOCAL [TELEPHONE TERMINAL BOARD (TTB)], [SYSTEMS TERMINAL BOARD (STB)], [OR COMPUTER TERMINAL BOARD (CTB)]. ALL TERMINATIONS AT [TTB][STB][CTB] SHALL BE AT DESIGNATED SECTION OF [TTB][STB][CTB]. COORDINATE WITH ALL SYSTEMS BEING TERMINATED ON [TTB][STB][CTB].

15) PROVIDE AND INSTALL CABLE/WIRING AS RECOMMENDED BY MANUFACTURER AND APPLICABLE CODES AND STANDARDS, UNLESS OTHERWISE CALLED FOR ON DRAWINGS OR IN SPECIFICATIONS. WHERE CONFLICT EXISTS, THE LARGEST SIZE CALLED FOR SHALL BE USED.

16) SIZE PATHWAYS AS RECOMMENDED BY MANUFACTURER AND APPLICABLE CODES AND STANDARDS UNLESS OTHERWISE CALLED FOR ON DRAWINGS OR IN SPECIFICATIONS. WHERE CONFLICT EXISTS, THE LARGEST SIZE CALLED FOR SHALL BE USED.

17) ALL COMMUNICATIONS WALL OUTLET BOXES SHALL BE 4-11/16" x 4-11/16" x 2-3/4" DEEP FLUSH BOXES WITH TRIM RING AS REQUIRED TO ACCOMMODATE WALL CONSTRUCTION AND OUTLET FACEPLATE.

18) SEE OUTLET DETAILS.

19) PROVIDE AND INSTALL (1) 4-PAIR CATEGORY 6 CABLE FOR EACH ACTIVE PORT IN EACH COMMUNICATION OUTLET CIRCUIT TO RESPECTIVE PATCH PANEL IN MDF/IDF AT LOCAL [TTB][STB][CTB] UNLESS NOTED OTHERWISE.

20) ALL ITEMS NOTED ON THE LEGENDS DO NOT NECESSARILY APPEAR ON PLANS.

AUDIO/VIDEO SYSTEMS SYMBOL LEGEND				
SYMBOL	DESCRIPTION	MOUNTING HEIGHT	MOUNTI	NG
(\$\(\dagge(*)\)	SOUND SYSTEM SPEAKER TRANSFORMER/ CONNECTION		FLUSH IN CLNO OTHERWISE	
LCD	TOUCH SCREEN LCD ROOM CONTROL PANEL	60" A.F.F. TO TOP	FLUSH WALL	
<u>PROJ</u> ⊲	LCD TYPE PROJECTOR	AS SHOWN ON DRAWINGS	AS SHOW DRAWIN	
(*)	COMMUNICATIONS OUTLET MOUNTED IN FLOOR BOX WITH MINIMUM 2"C EXTENDED ABOVE CEILING AND TURNED INTO ROOM IT SERVES, OR CABLE TRAY BELOW (LEVEL 2 ONLY). FOB SHALL BE LEGRAND #EFB8S (ON GRADE OR FIRE RATED A/R) (*) = DENOTES OUTLET TYPE	FLOOR	FLUSH	
AVEC	AUDIO/VISUAL EQUIPMENT CABINET		FREE STANDING	

AUDIBLE VIDEO SYSTEM GENERAL NOTES

1) REFER TO SPECIFICATIONS.

2) REFER TO SPECIFICATIONS FOR BASIS OF DESIGN.

3) REFER TO DETAILS.

4) REFER TO SYSTEM BLOCK DIAGRAM.

5) ELECTRICAL CONTRACTOR TO PROVIDE PULL STRINGS IN ALL EMPTY RACEWAYS.

6) LOCATION OF ALL DEVICES ON PLANS ARE APPROXIMATE ONLY. VERIFY EXACT LOCATIONS, HEIGHTS, ETC. WITH OWNER AND/OR ARCHITECT PRIOR TO ROUGH-IN.

7) PROVIDE CABLE TO ALL OUTLETS UNLESS SPECIFICALLY NOTED OTHERWISE.

8) ALL CABLES/RACEWAYS TO BE CONCEALED UNLESS SPECIFICALLY NOTED OTHERWISE OR APPROVED BY ENGINEER. SEE SPECIFICATIONS AND GENERAL NOTES FOR ADDITIONAL CLARIFICATIONS.

9) ALL SYSTEM CABLES SHALL BE CAT6A AND SHALL BE INSTALLED IN RACEWAYS.

10) PROVIDE FIRESTOPPING ON ALL CONDUITS AND SLEEVES PENETRATING A RATED WALL OR FLOOR.

11) COORDINATE EXACT INSTALLATION REQUIREMENTS OF OUTLETS IN MILLWORK WITH ARCHITECTURAL DRAWINGS AND APPROVED MILLWORK SHOP DRAWINGS.

12) ALL RACEWAY TERMINATIONS SHALL HAVE BUSHINGS AND BE GROUNDED WHERE RACEWAY IS METAL.

13) COORDINATE WITH FIRE ALARM CONTRACTOR PRIOR TO BID.

14) ALL ITEMS NOTED ON THE LEGENDS DO NOT NECESSARILY APPEAR ON PLANS.

15) CAT 6+ F/UTP CABLE TO AV CABINET.

16) ROUTE ALL COAX TO DESIGNATED SECTION OF TTB AND PROVIDE DISTRIBUTION AMP AND EQUIPMENT.

17) PROVIDE ALL REQUIRED ACCESORIES FOR FOB REQUIRED TO INSTALL ALL NOTED POWER, DATA, AND AV OUTLETS AND CABLING

DEMOLITION LEGEND

REMOVE ALL ELECTRICAL ASSOCIATED WITH THIS ITEM, COMPLETE BACK TO ITS SOURCE. SOURCE IS CONSIDERED TO BE FIRST UPSTREAM DEVICE OR CIRCUIT BREAKER THAT FEEDS THIS AFFECTED CIRCUIT. SEE GENERAL NOTES AND SPECIFICATIONS FOR ADDITIONAL REQUIREMENTS.

REMOVE ALL ELECTRICAL IN AREA OF REMODEL/RENOVATION COMPLETE BACK TO ITS SOURCE. SOURCE IS CONSIDERED TO BE FIRST UPSTREAM DEVICE OR CIRCUIT BREAKER OUTSIDE OF AREA OF REMODEL THAT FEEDS CIRCUITS/DEVICES WITHIN AREA OF REMODEL/RENOVATION. SEE GENERAL NOTES AND SPECIFICATIONS FOR ADDITIONAL REQUIREMENTS.

R3) REMOVE THE DEVICE ONLY. REFER TO RENOVATION PLAN FOR ADDITIONAL

ABANDON COMPLETE. PULL OUT CONDUCTORS. REMOVE ALL VISIBLE SECTIONS OF RACEWAY.

REMOVE COMPLETE AS NOTED ABOVE EXCEPT THAT PORTIONS OF CONDUIT CONCEALED UNDERGROUND OR IN CONCRETE MAY BE ABANDONED, AS NOTED ABOVE

ETT EXISTING WALLS TO BE REMOVED COMPLETE.

EXISTING WALLS TO REMAIN.

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MPE JOB #: 2017-090

THE
COMMISSION
CHAMBER'S
AUDIO VISUAL
RENOVATION

1126 E STATE RD 434, WINTER SPRINGS, FL 32708

CITY OF

SPRINGS

Professional Seal

No.	Description	Date

GENERAL NOTES AND SYMBOL LEGENDS

Project Number 2017-090

Designed By DAM/RS

Drawn By RS


Checked By MPE

Scale As indicated


Date 7/14/2017

Project Status 90% SUBMITTAL

F-003

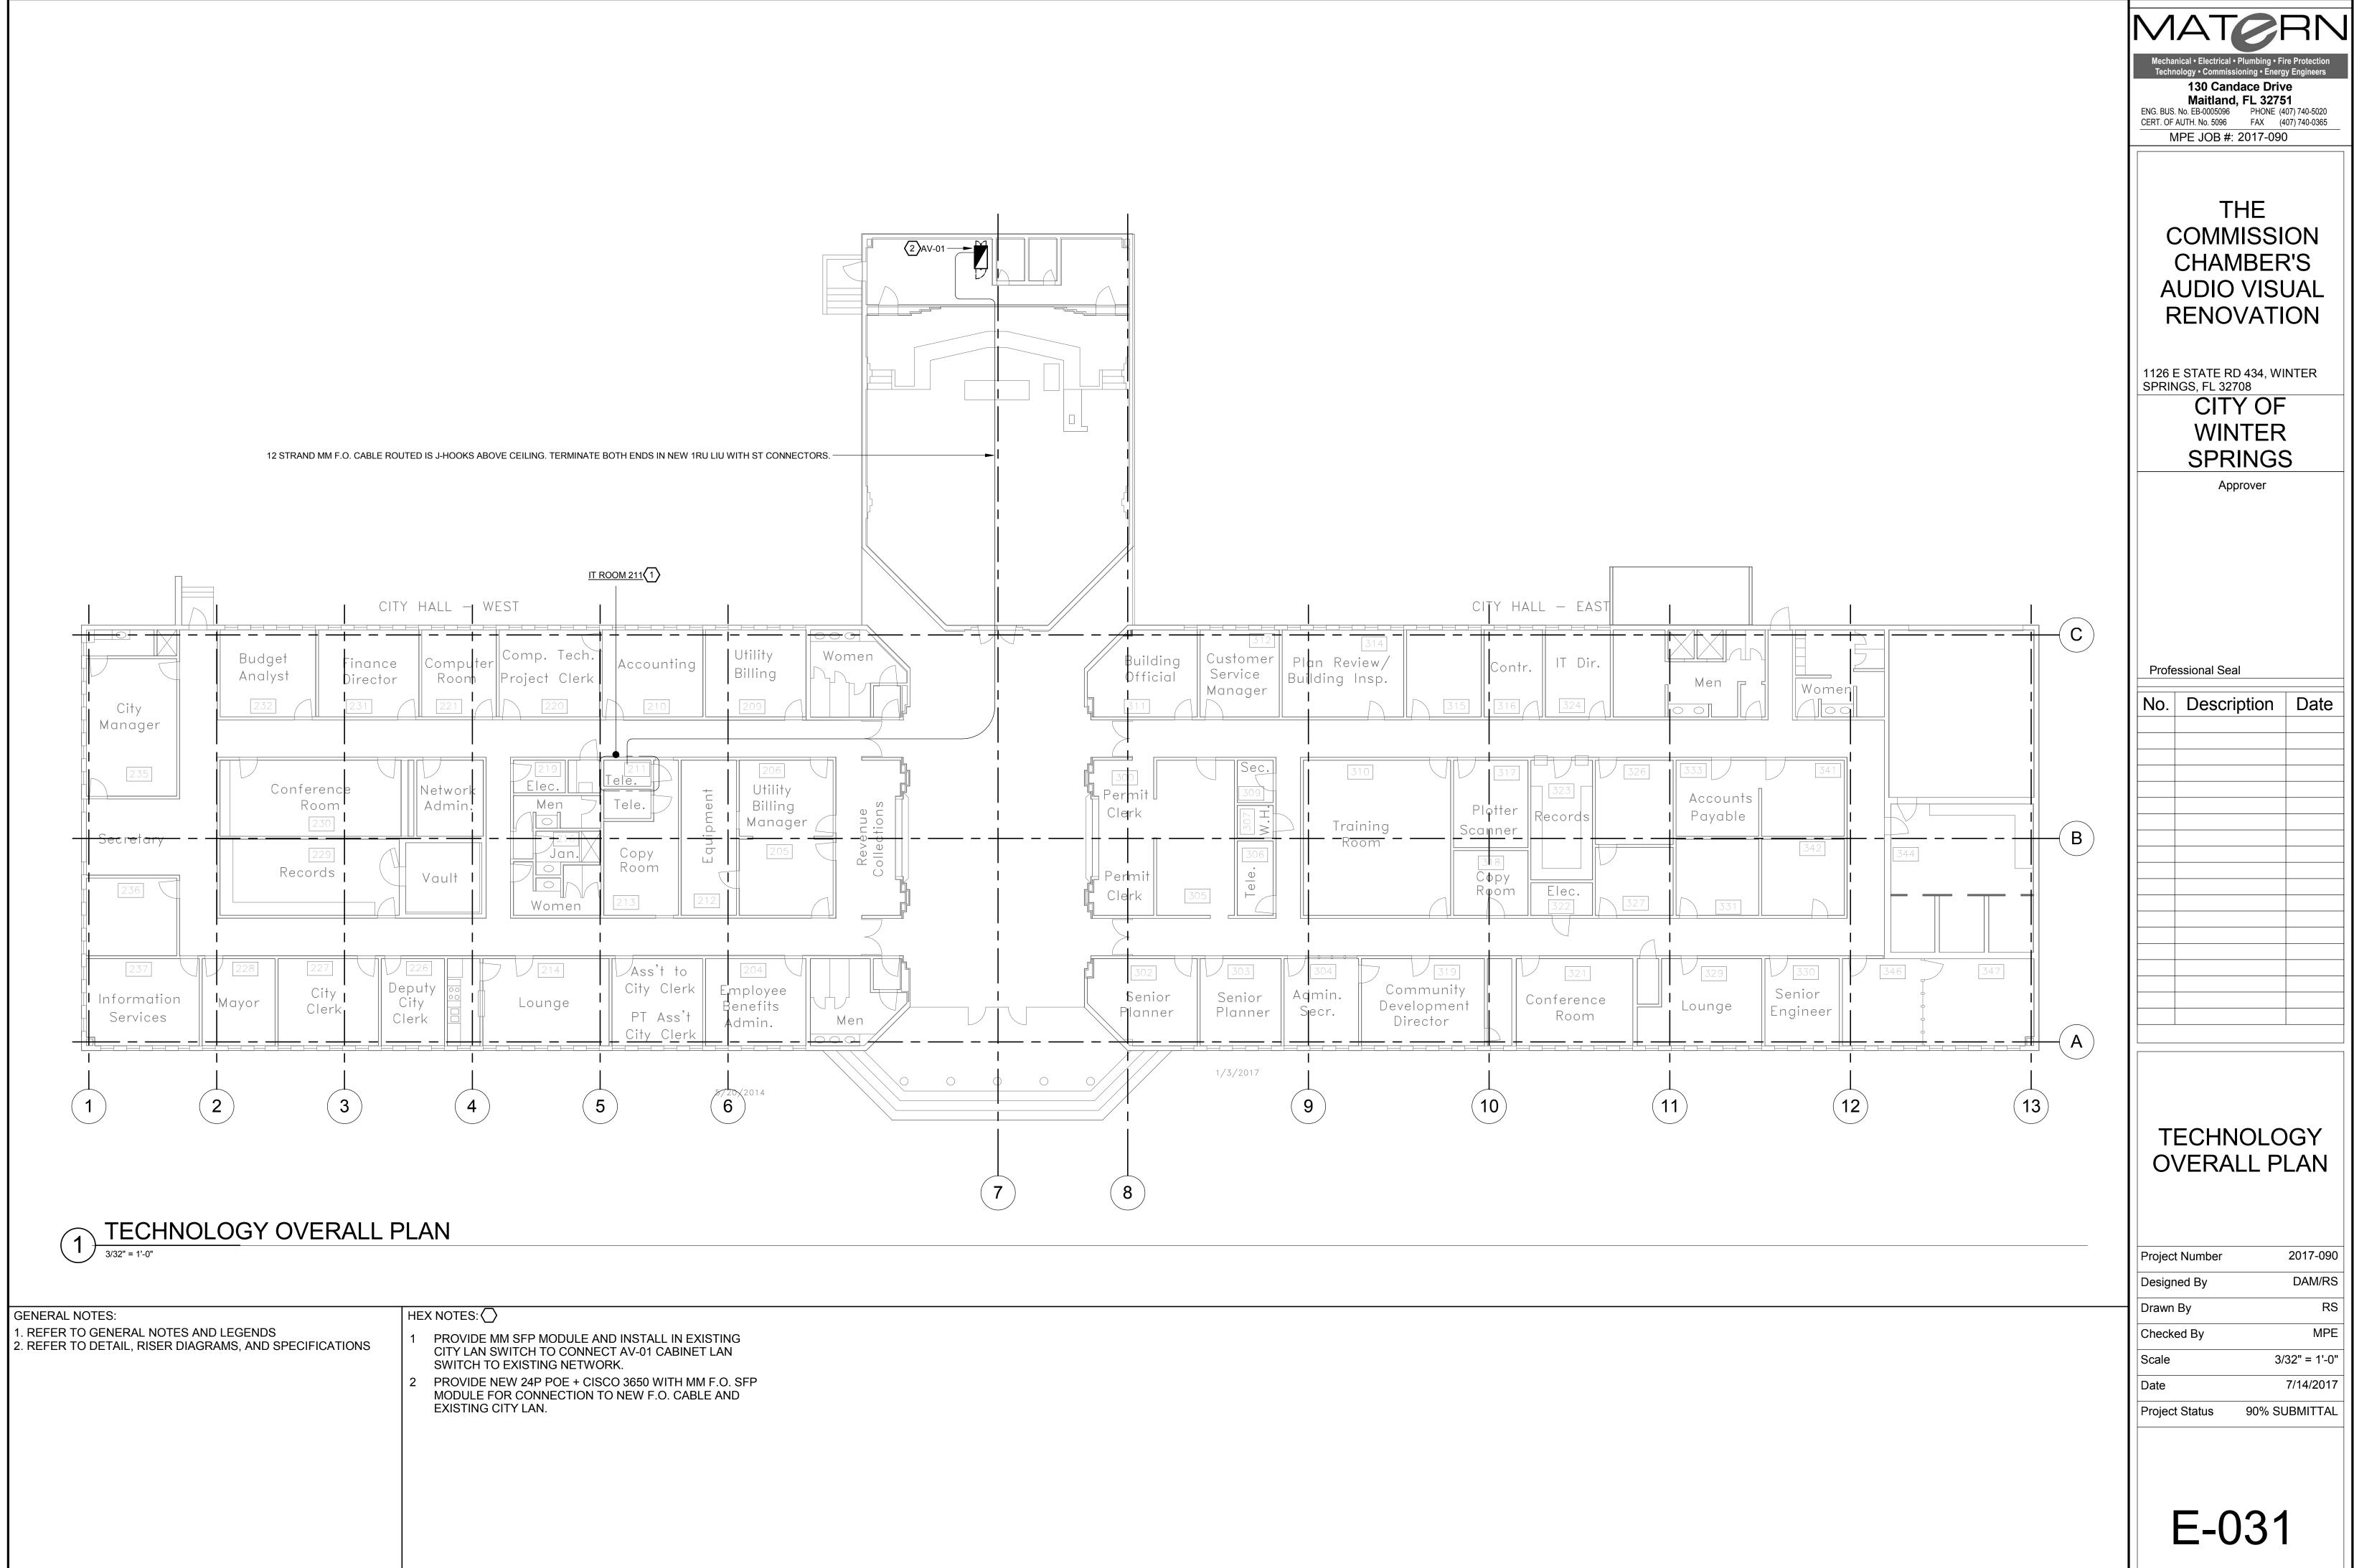

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THE COMMISSION CHAMBER'S **AUDIO VISUAL** RENOVATION

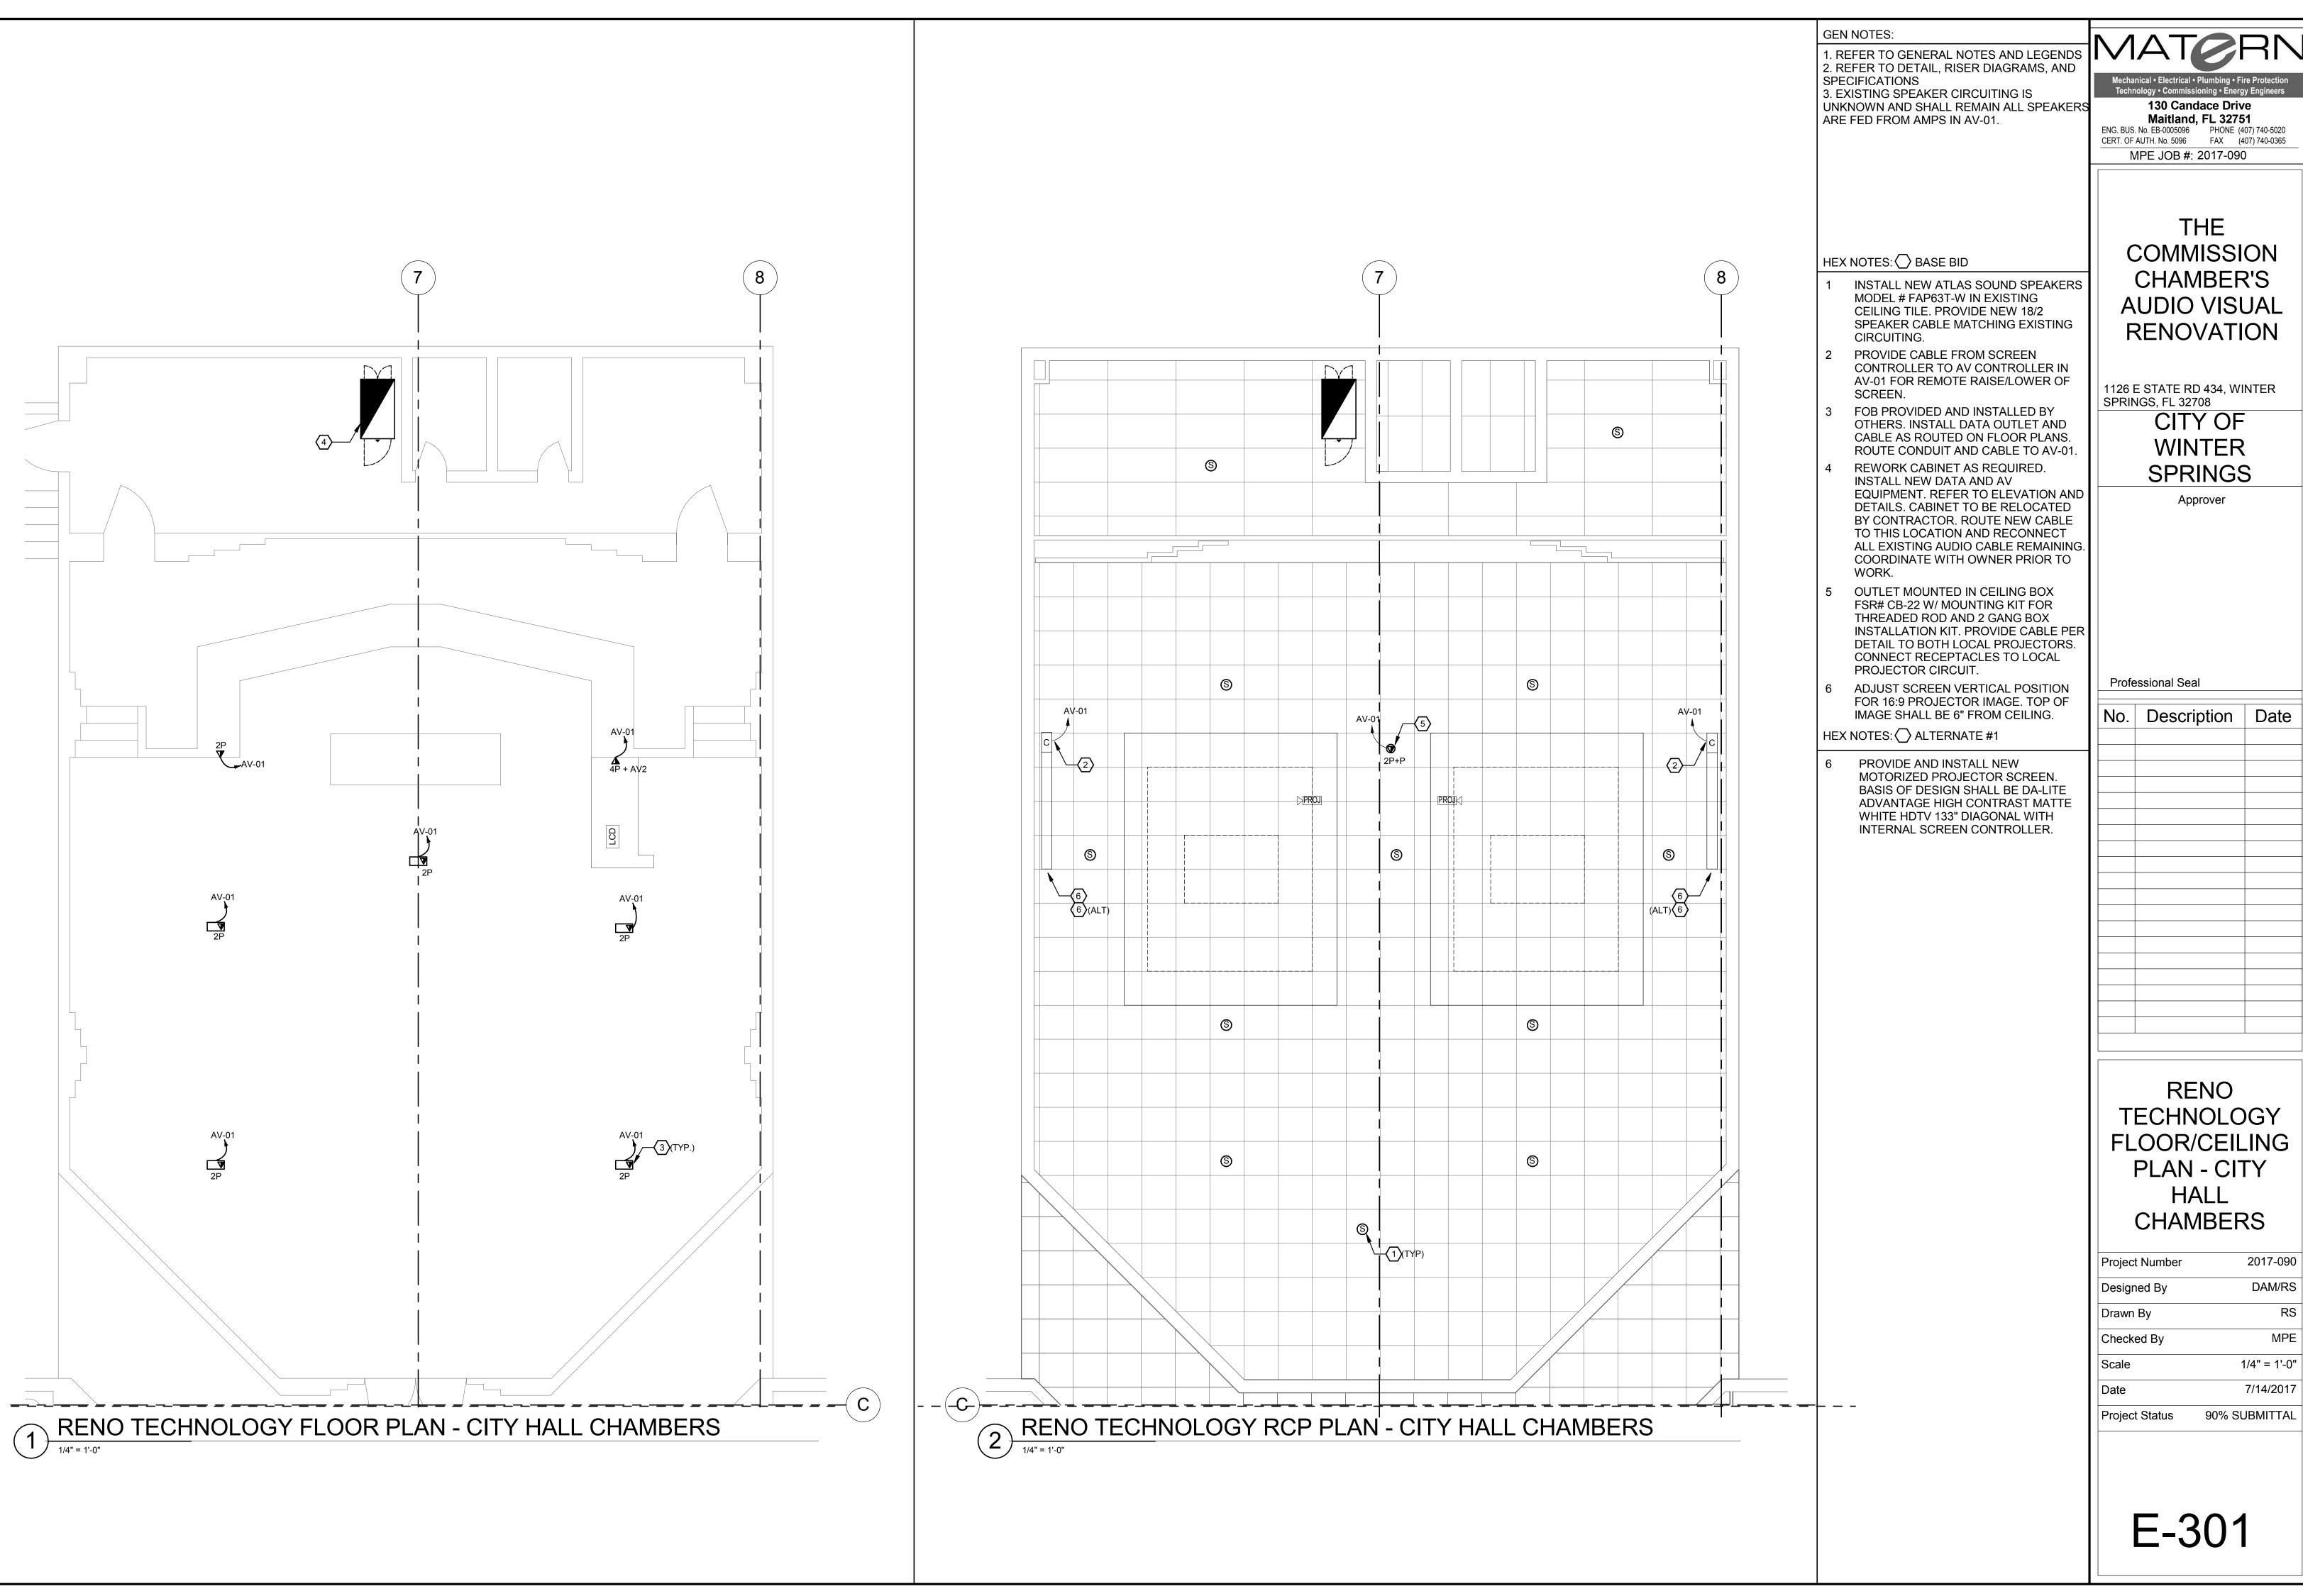1126 E STATE RD 434, WINTER


CITY OF WINTER **SPRINGS**

No. Description Date

RENO TECHNOLOGY FLOOR/CEILING PLAN - CITY HALL CHAMBERS

2017-090 Project Number DAM/RS 1/4" = 1'-0" 7/14/2017 90% SUBMITTAL

E-301

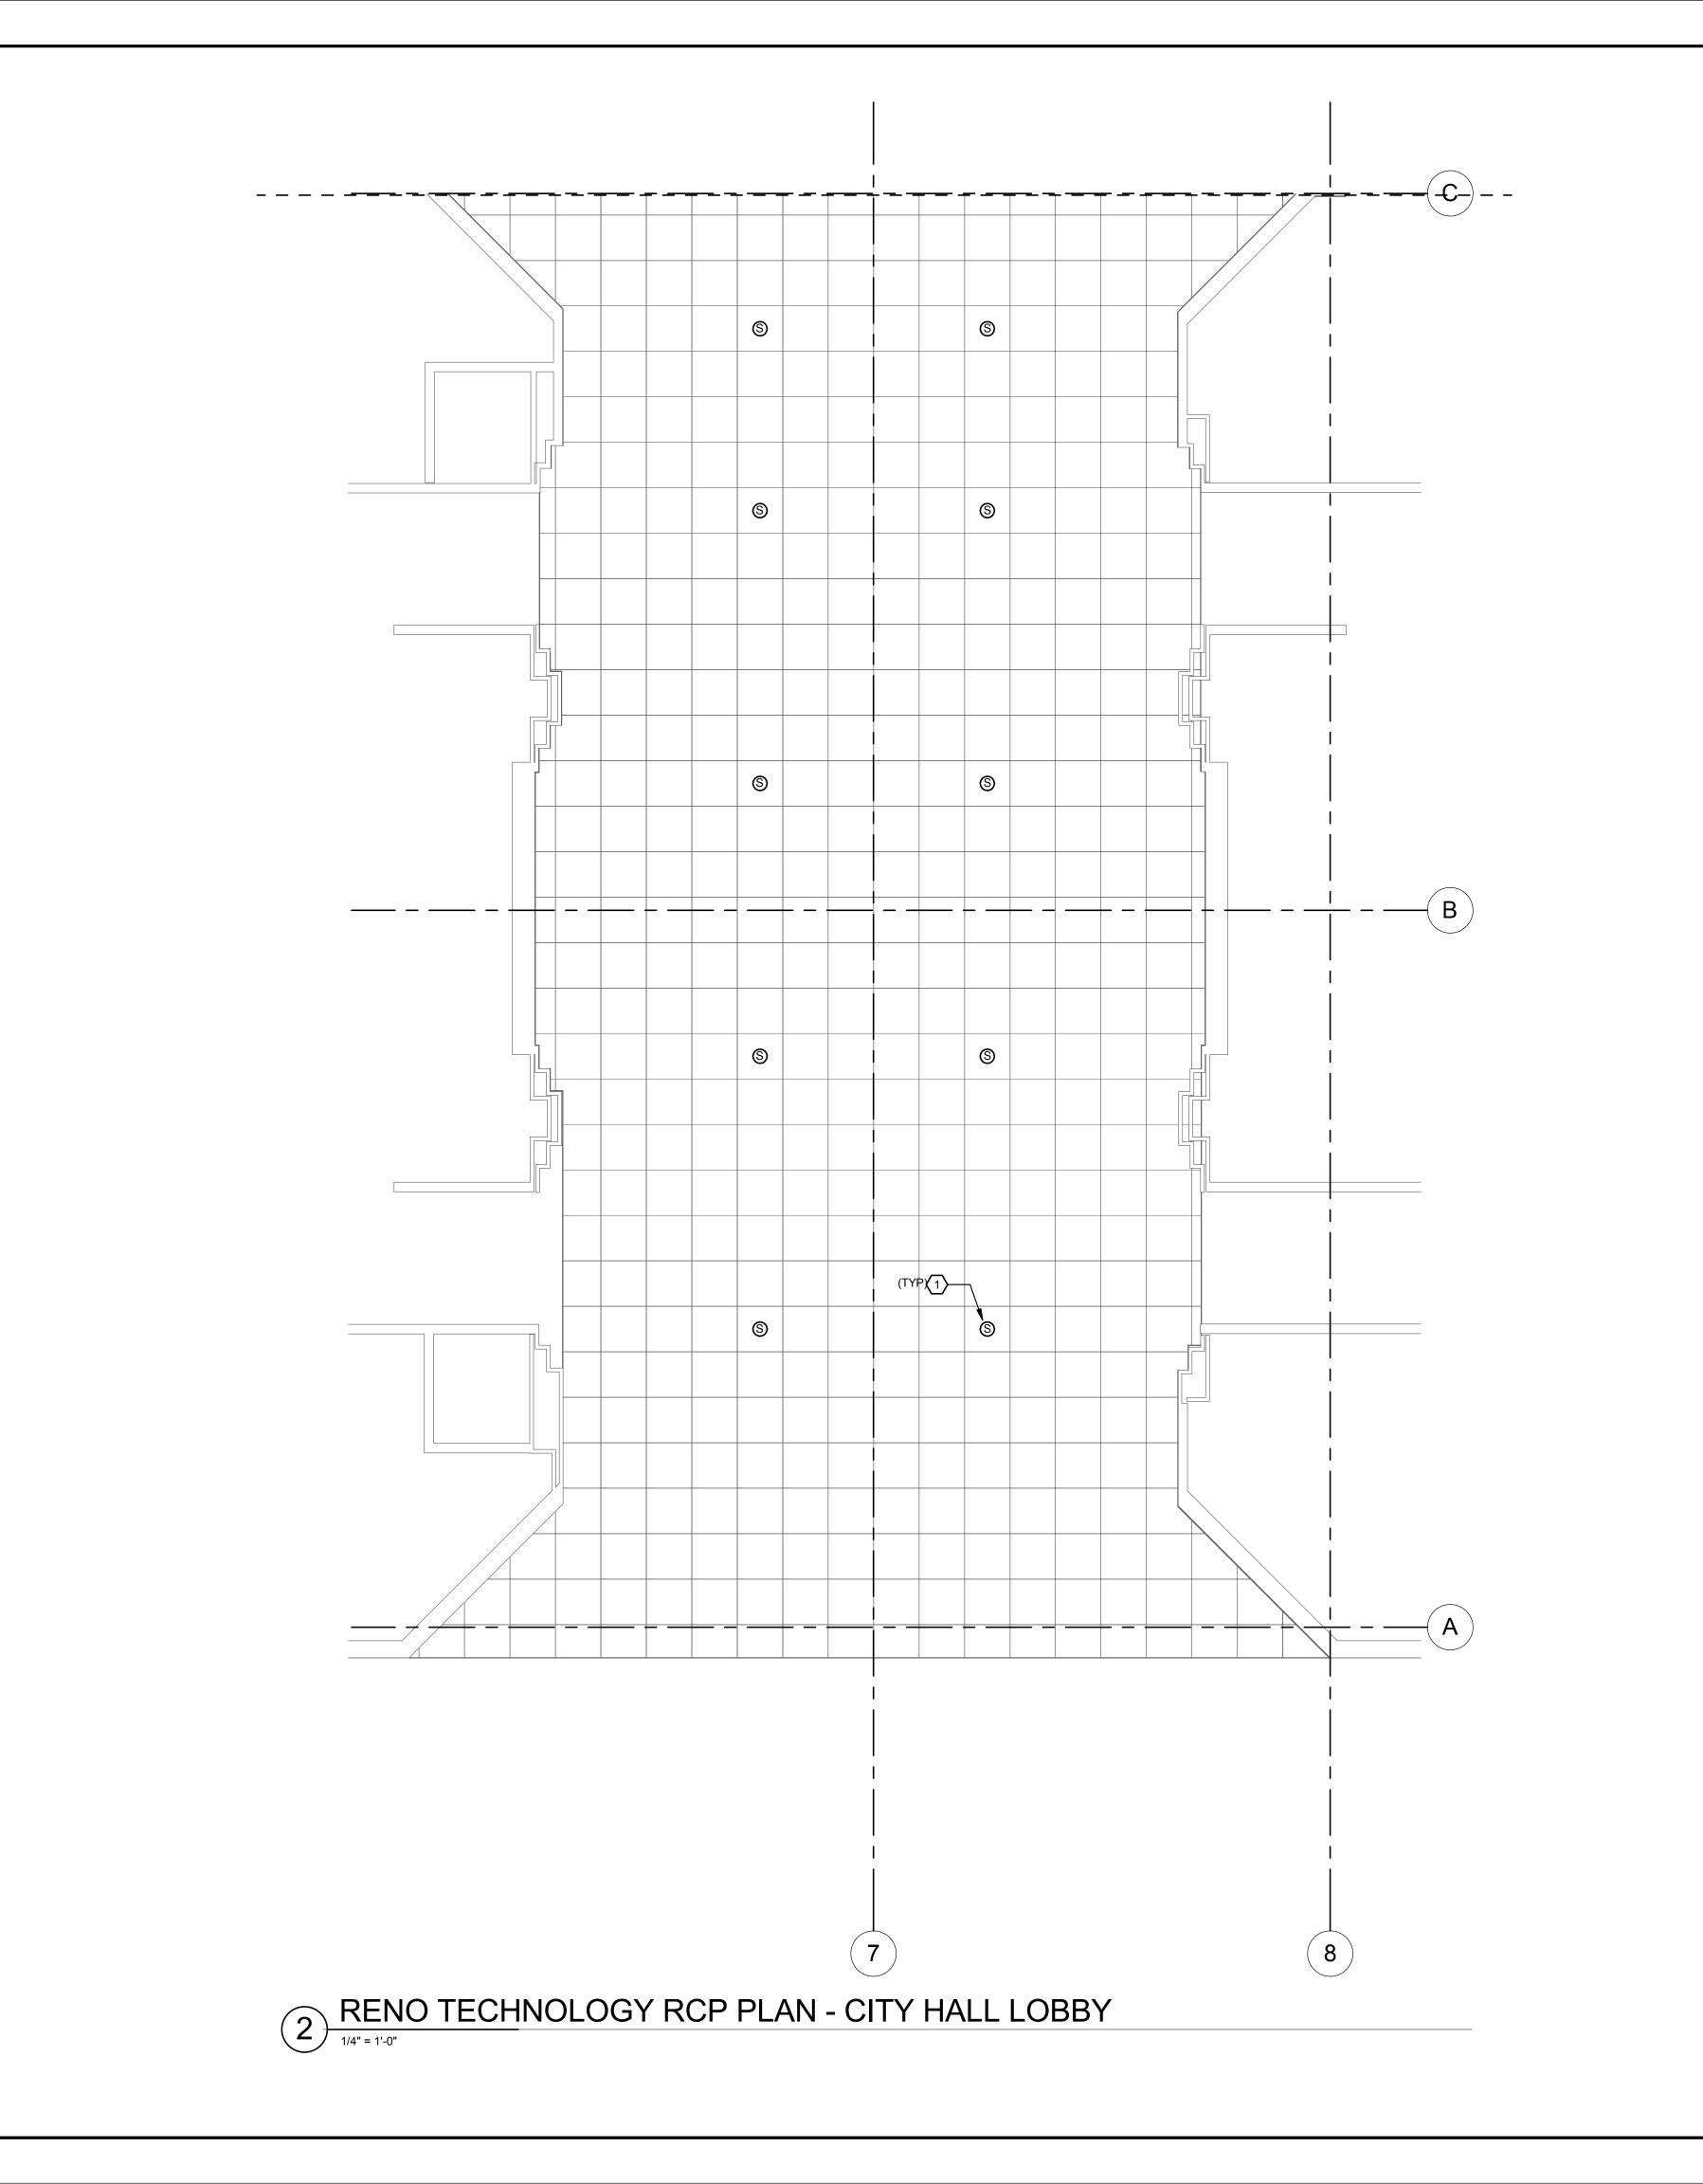

GEN NOTES:

1. REFER TO GENERAL NOTES AND LEGENDS
2. REFER TO DETAIL, RISER DIAGRAMS, AND
SPECIFICATIONS SPECIFICATIONS

HEX NOTES: ◯ BASE BID

CIRCUITING.

3. EXISTING SPEAKER CIRCUITING IS UNKNOWN AND SHALL REMAIN ALL SPEAKERS ARE FED FROM AMPS IN AV-01.

1 INSTALL NEW ATLAS SOUND SPEAKERS MODEL # FAP63T-W IN EXISTING

CEILING TILE. PROVIDE NEW 18/2 SPEAKER CABLE MATCHING EXISTING 130 Candace Drive

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THE COMMISSION CHAMBER'S **AUDIO VISUAL**

RENOVATION 1126 E STATE RD 434, WINTER

SPRINGS, FL 32708 CITY OF WINTER SPRINGS

Approver


Professional Seal

No. Description Date

RENO TECHNOLOGY CEILING PLAN -CITY HALL LOBBY

2017-090 Project Number DAM/RS Designed By Drawn By Checked By 1/4" = 1'-0" 7/14/2017 90% SUBMITTAL Project Status

E-302

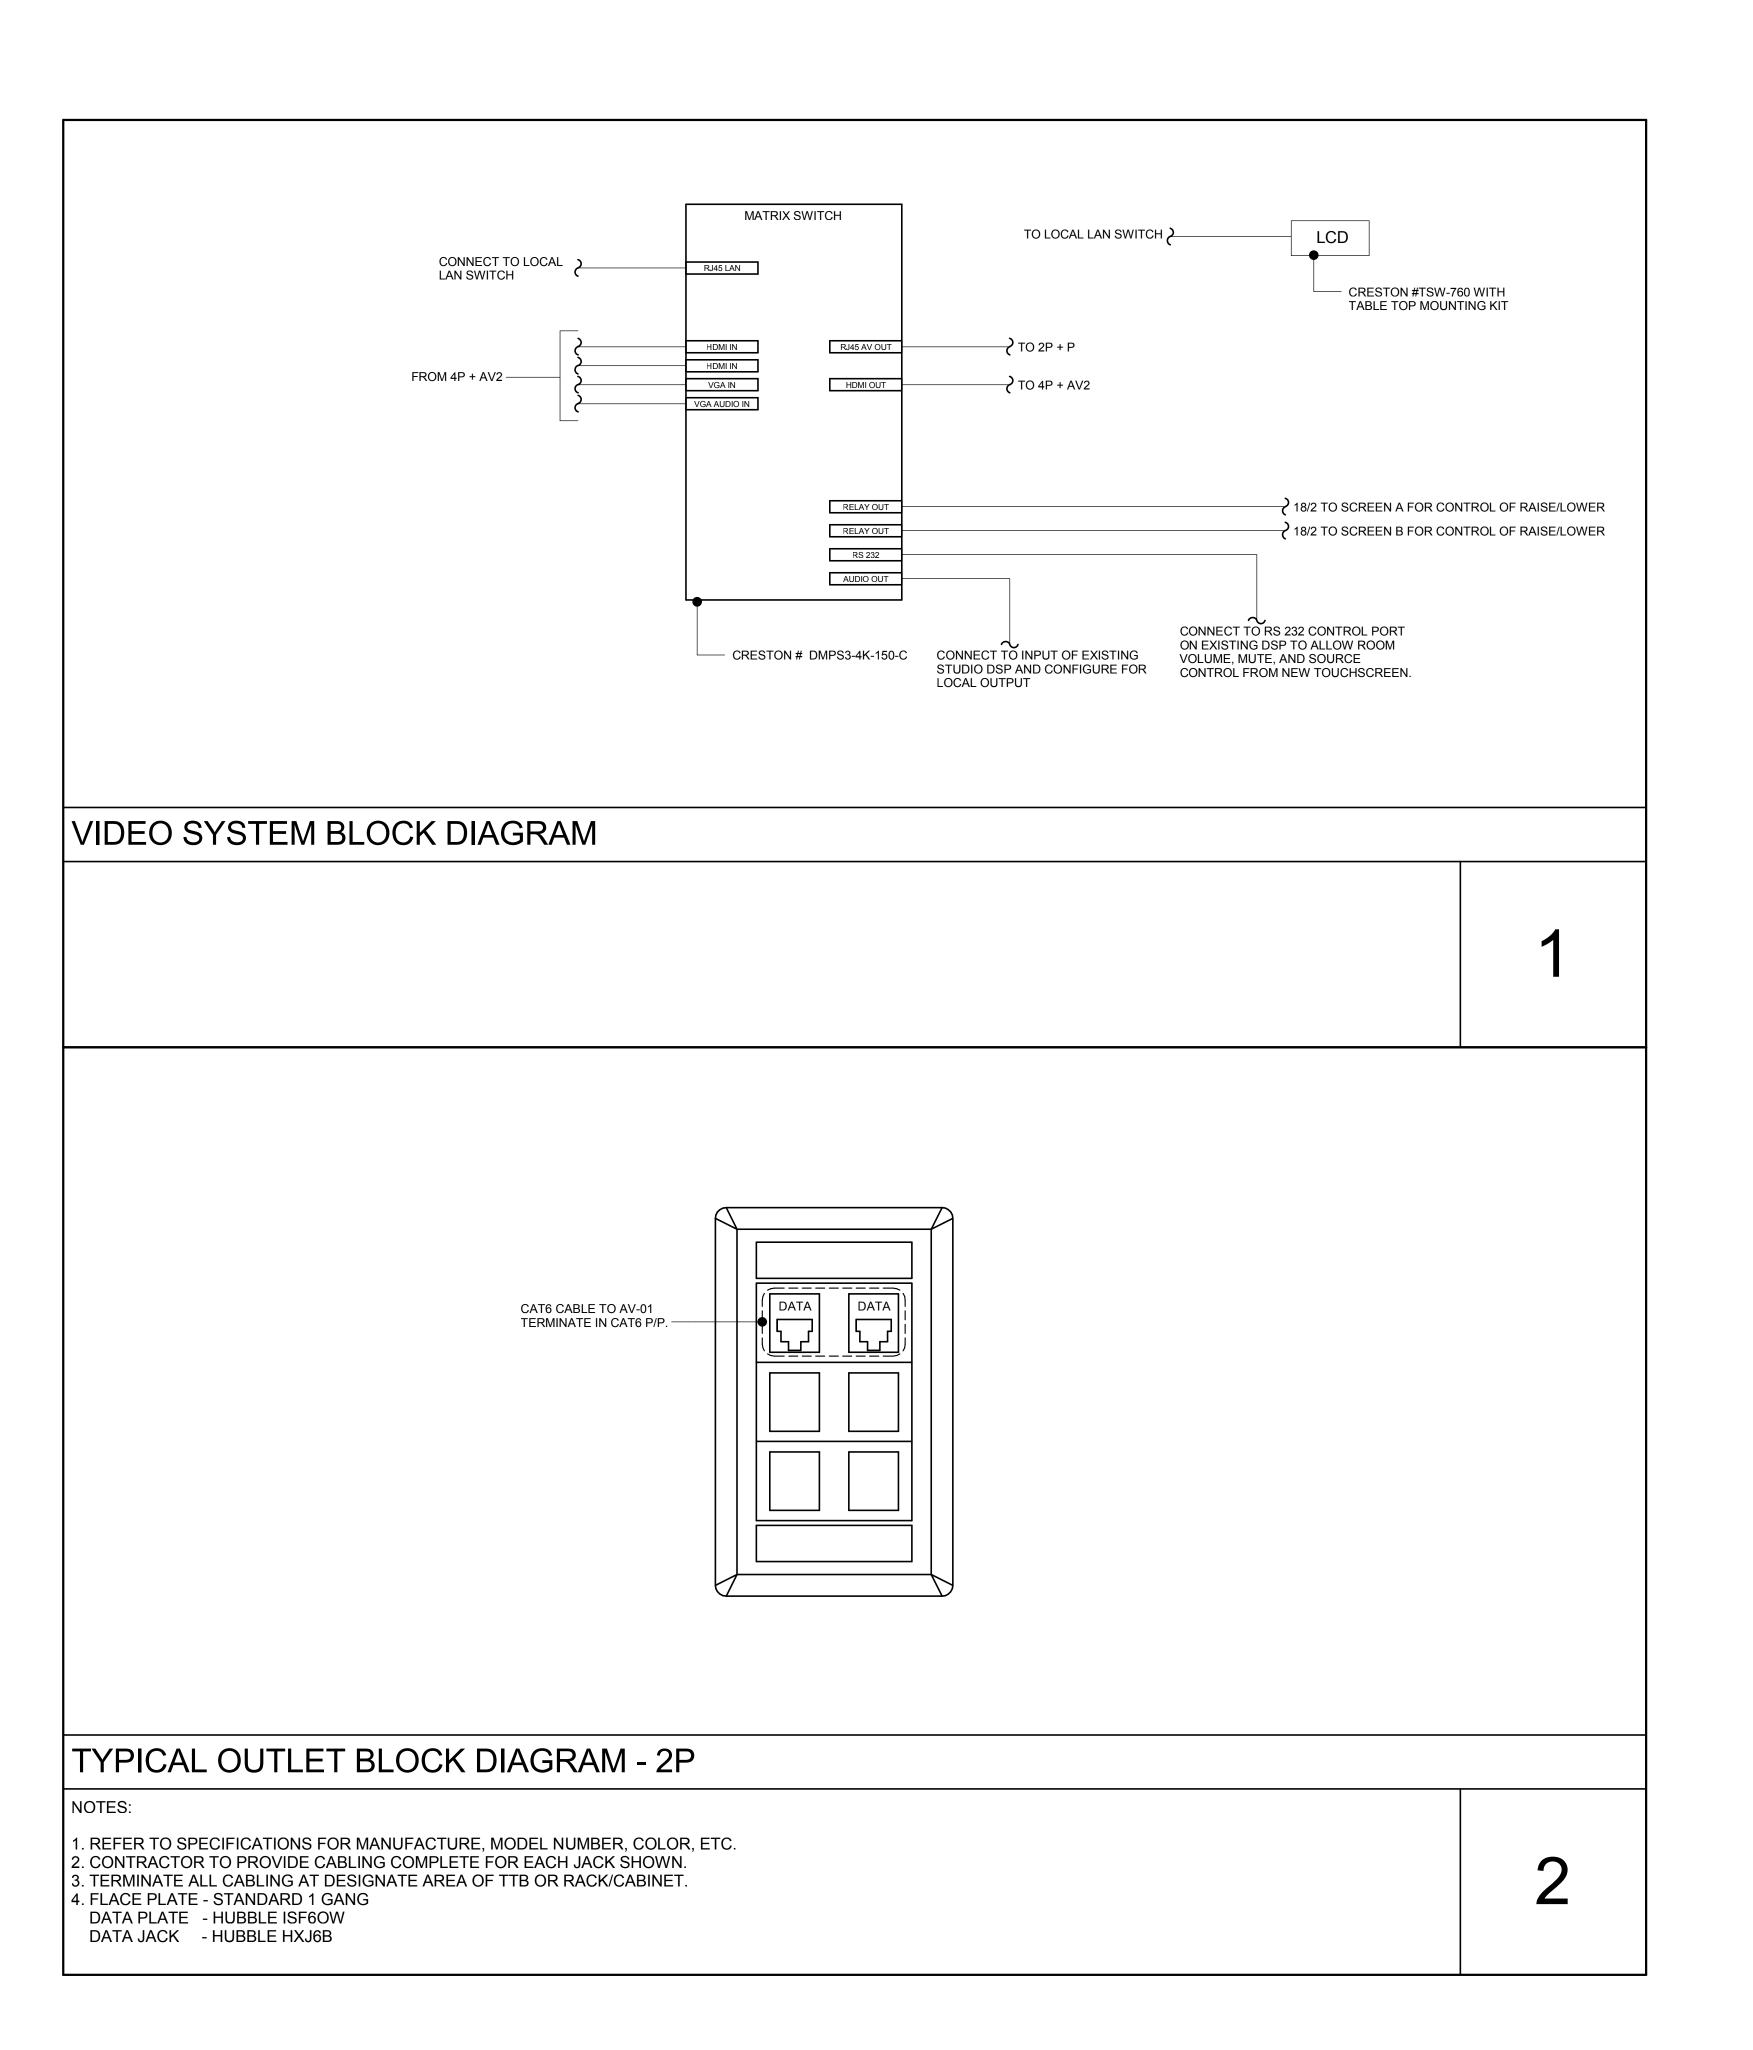

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MPE JOB #: 2017-090

THE
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RENOVATION

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CITY OF WINTER SPRINGS

Approver


Professional Seal

No.	Description	Date

TECHNOLOGY BLOCK DIAGRAM

Project Number	2017-090
Designed By	DAM/RS
Drawn By	RS
Checked By	MPE
Scale	1/8" = 1'-0"
Date	7/14/2017
Project Status	90% SUBMITTAL

E-801

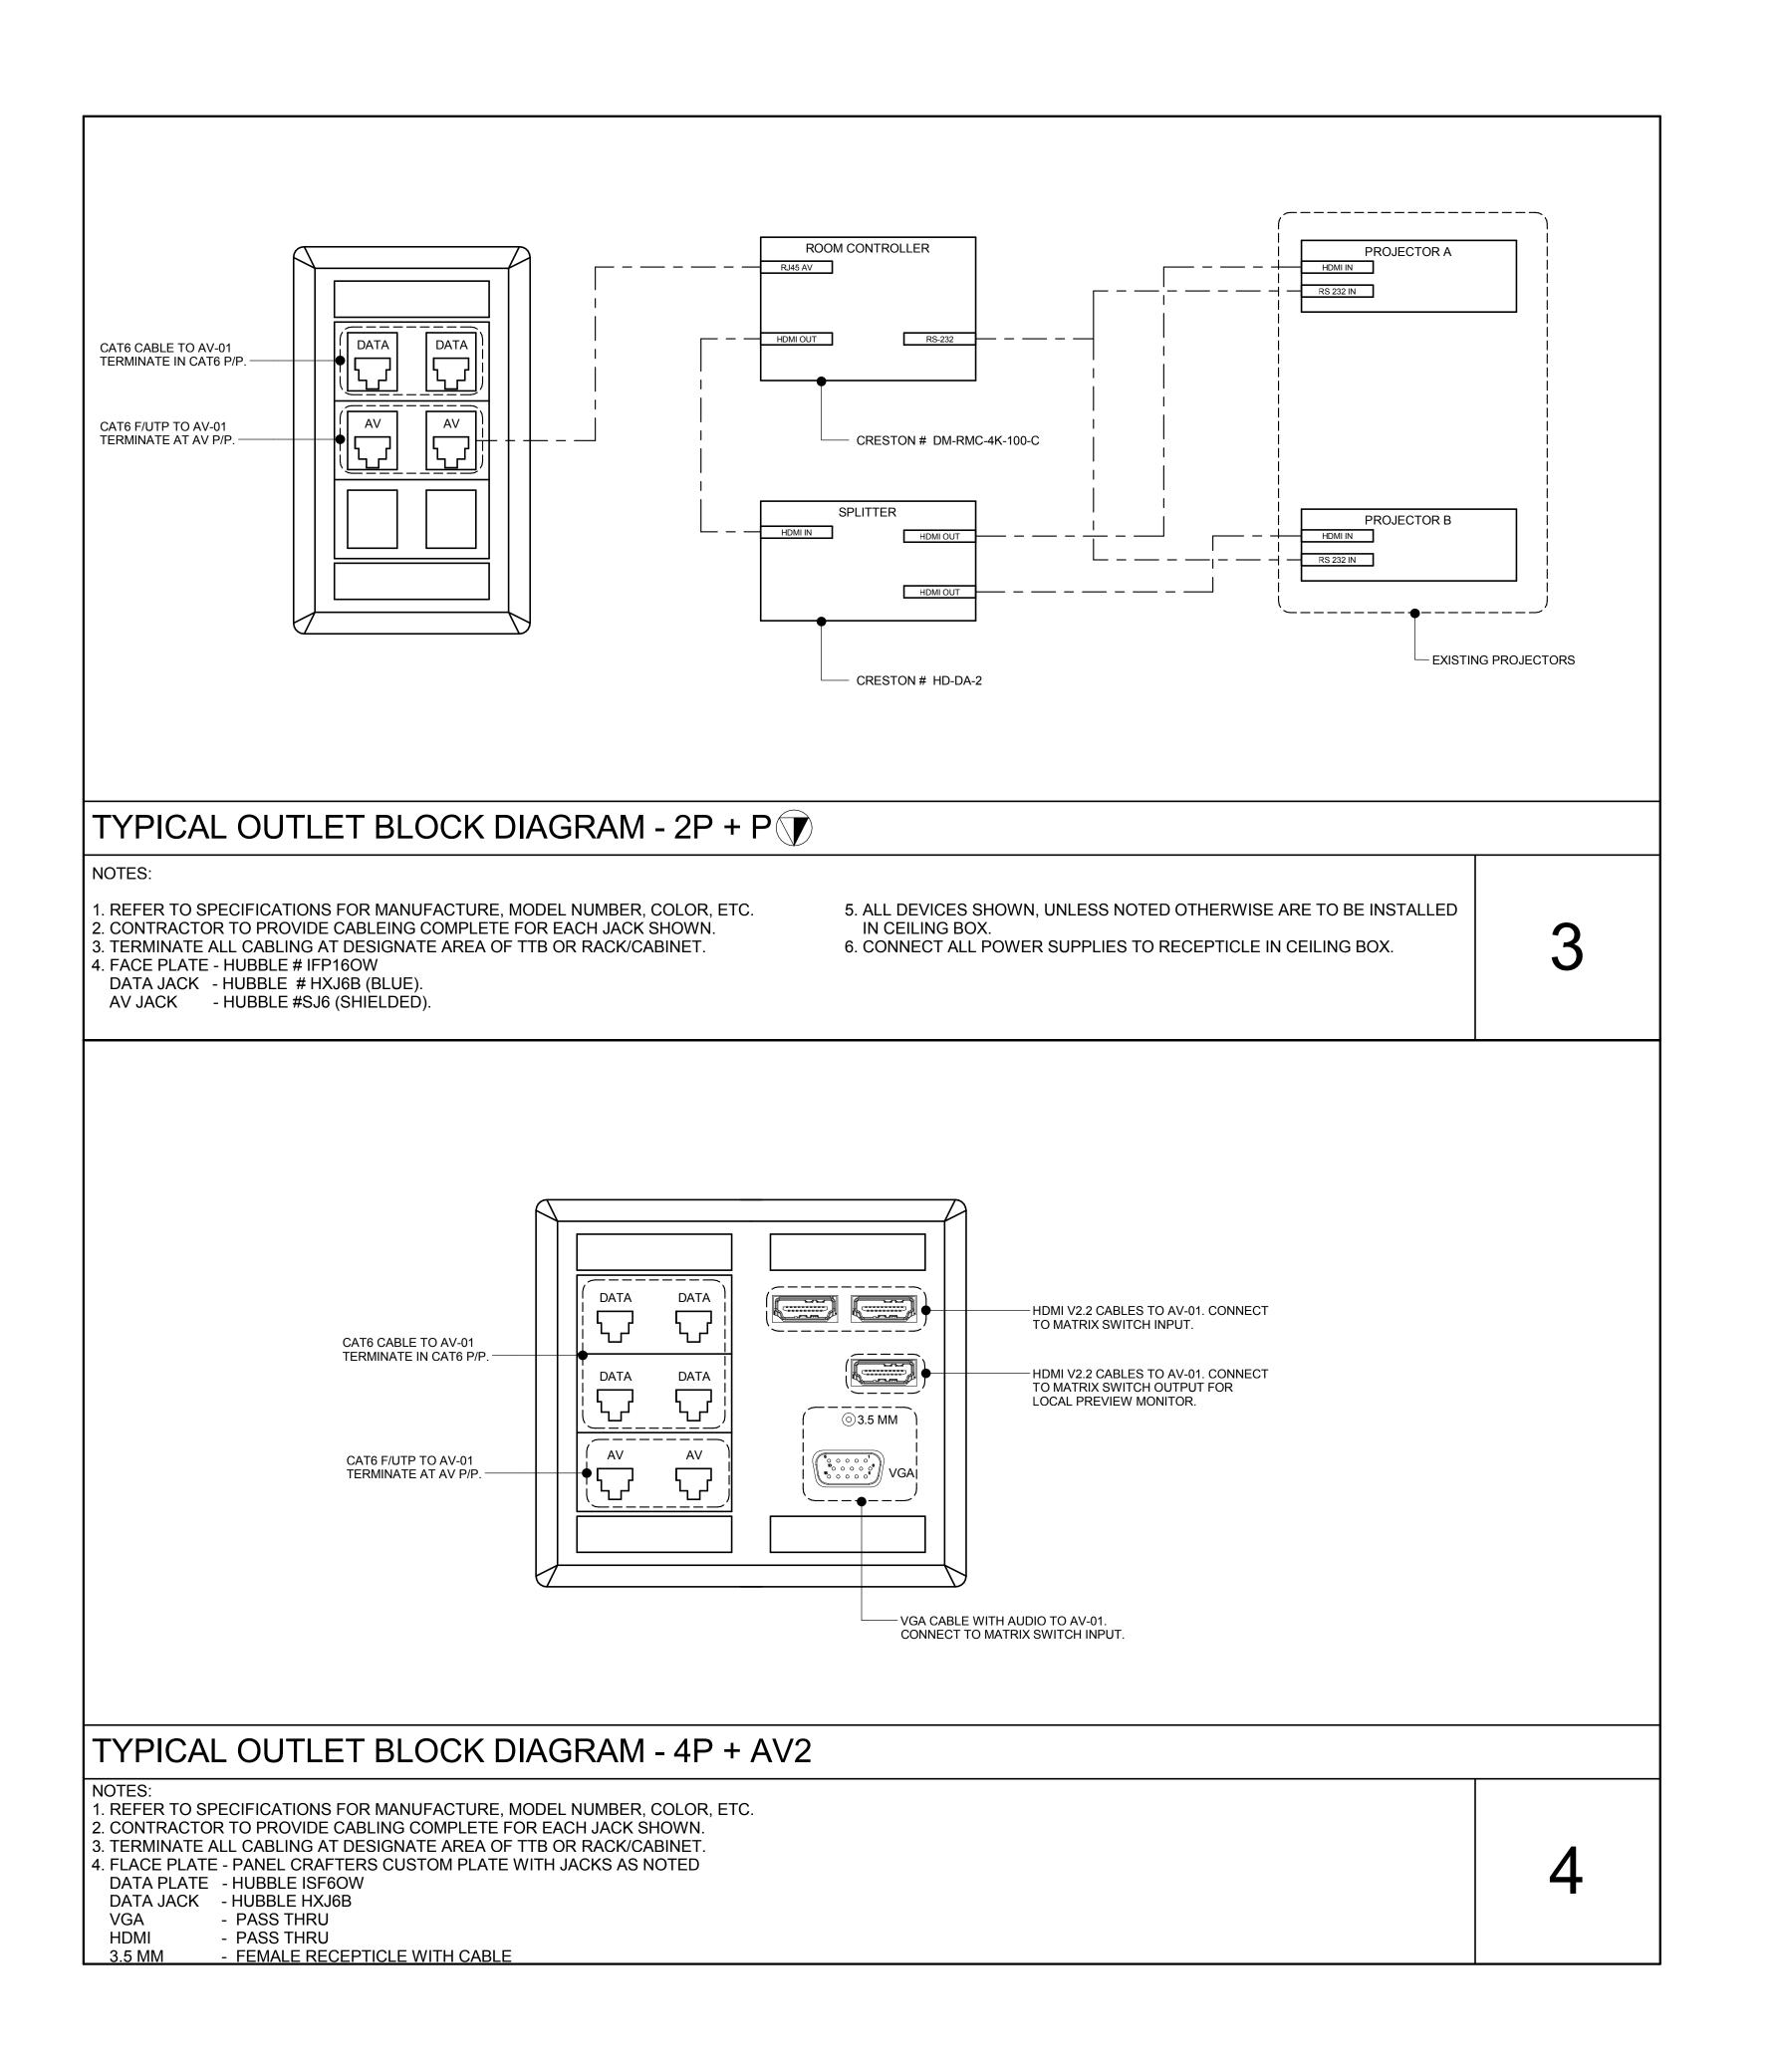

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MPE JOB #: 2017-090

THE
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CHAMBER'S
AUDIO VISUAL
RENOVATION

1126 E STATE RD 434, WINTER SPRINGS, FL 32708

CITY OF WINTER SPRINGS

Approver

Professional Seal

No. Description Date

TECHNOLOGY BLOCK DIAGRAM

Project Number 2017-090

Designed By DAM/RS

Drawn By RS

Checked By MPE


Scale 1/8" = 1'-0"

Date 7/14/2017

Project Status 90% SUBMITTAL

=-802

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MPE JOB #: 2017-090

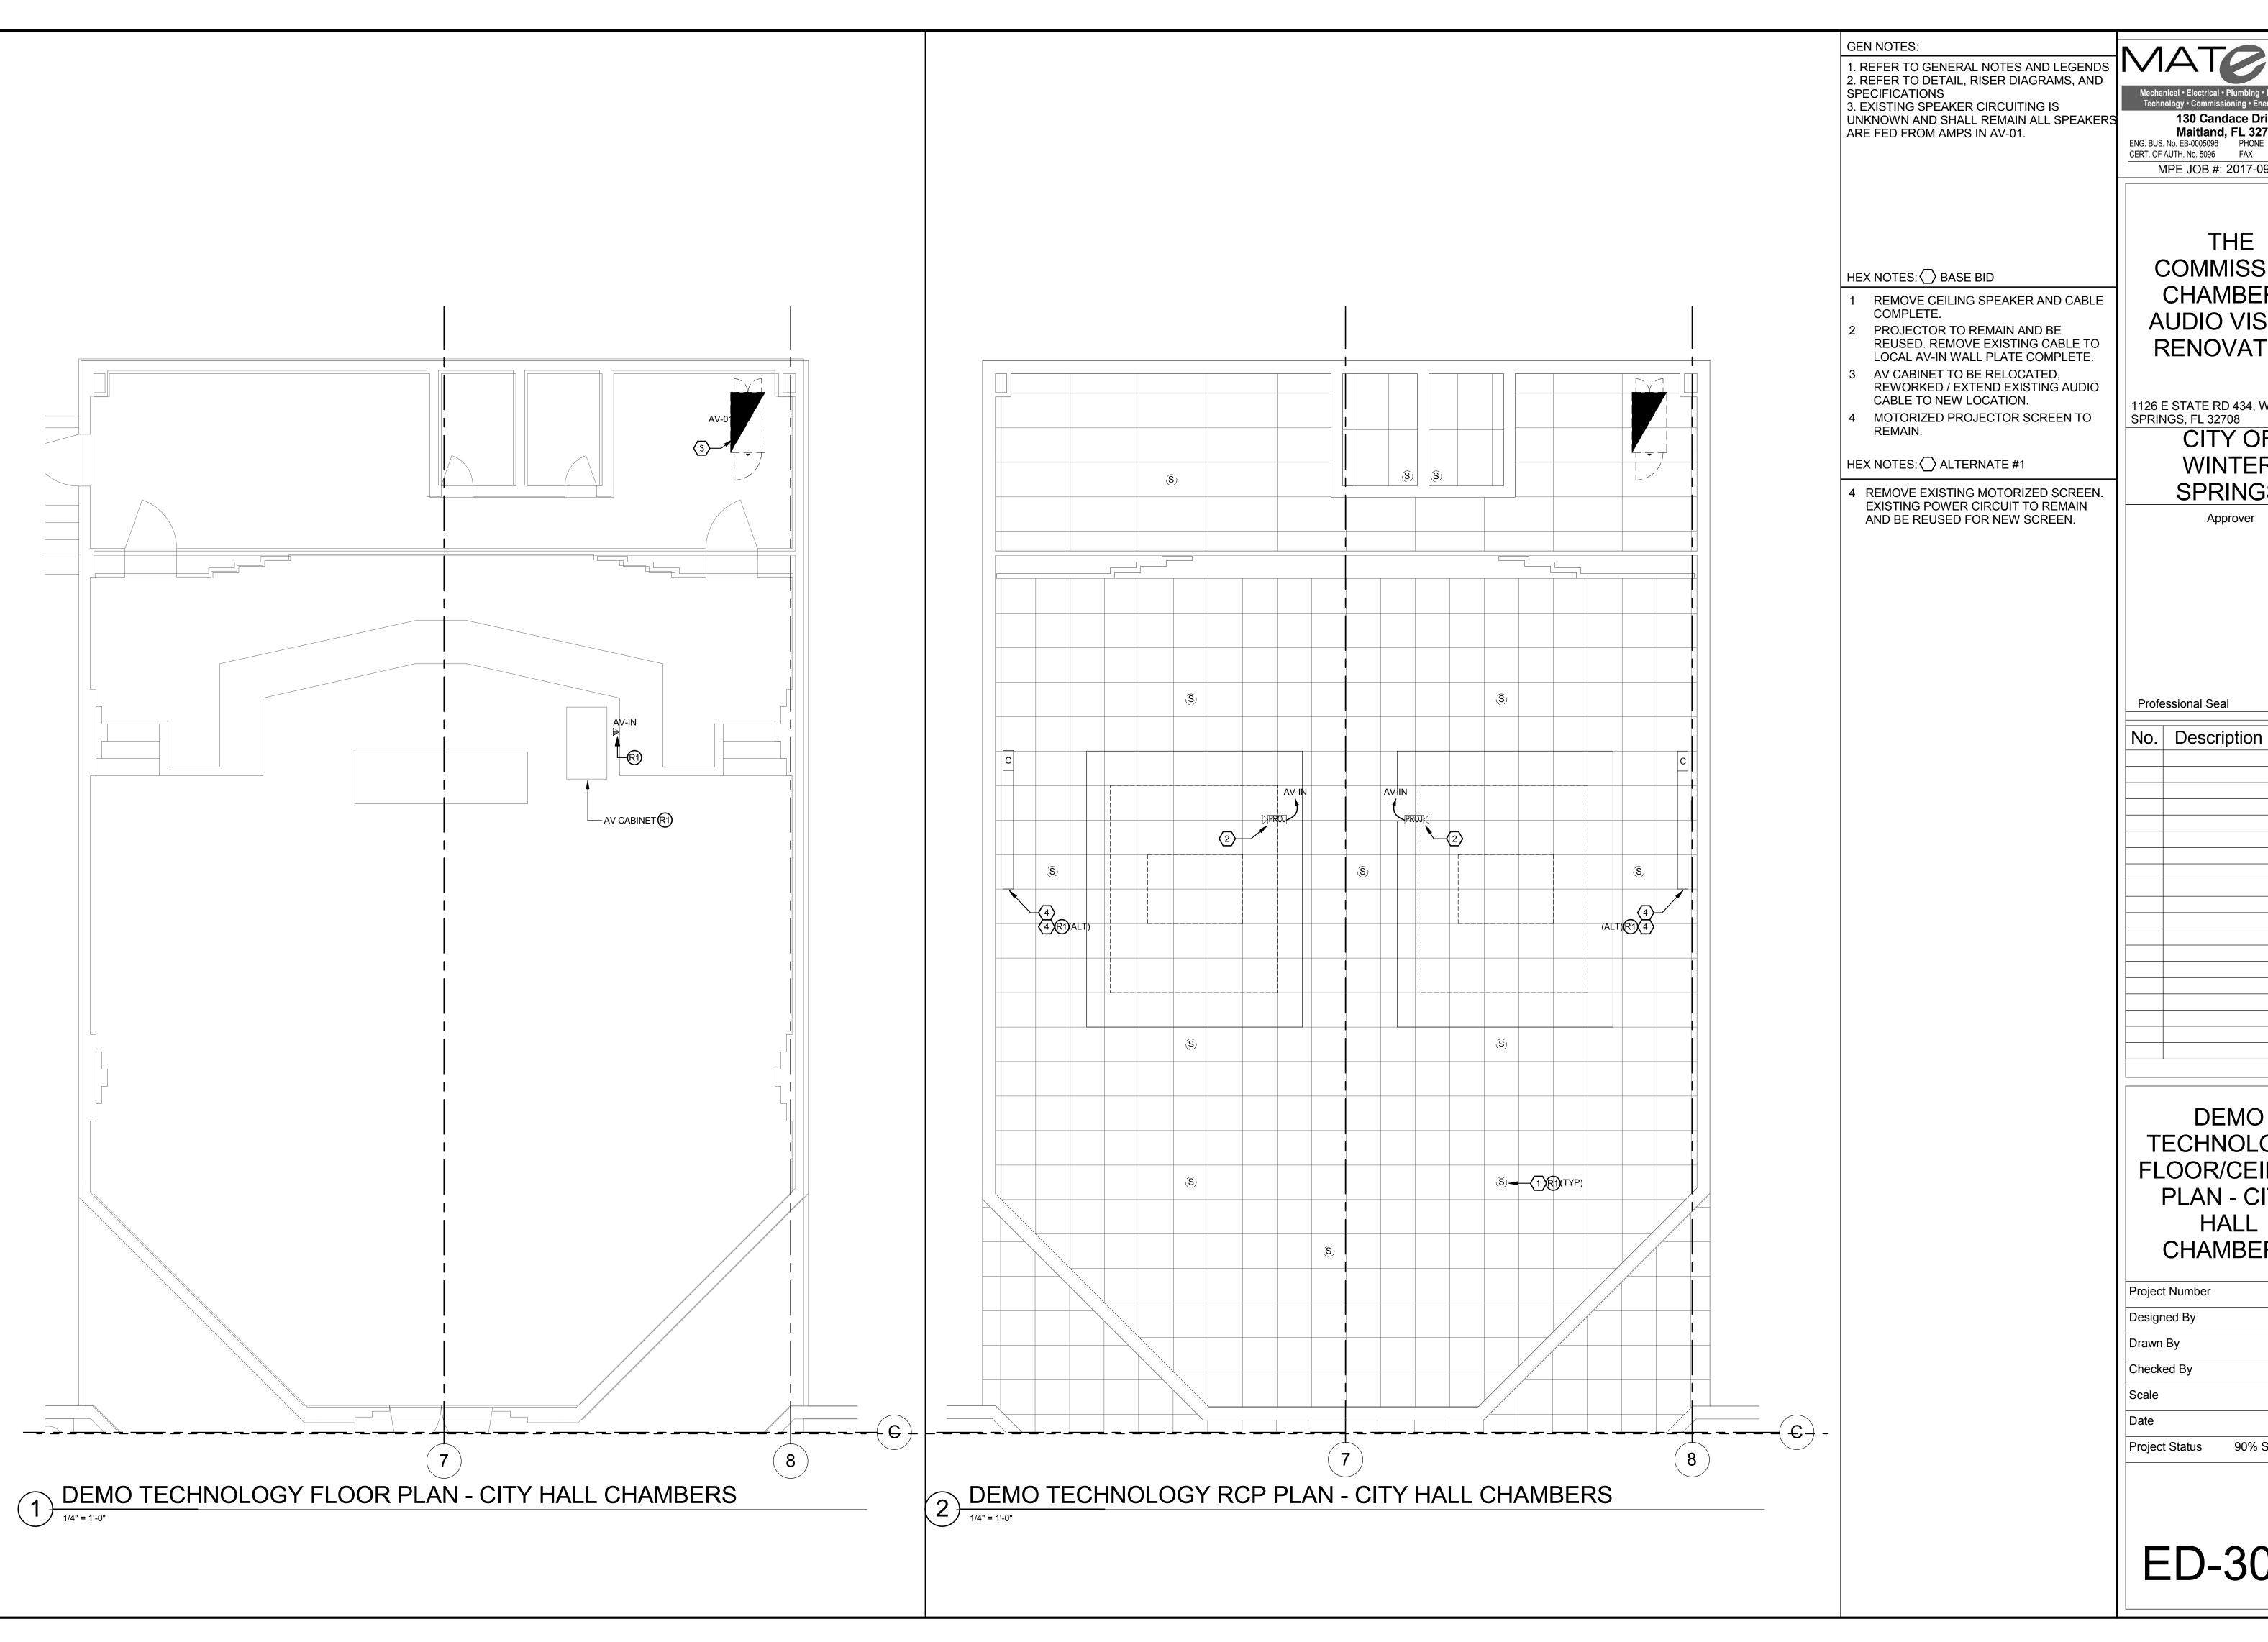THE COMMISSION CHAMBER'S

RENOVATION

1126 E STATE RD 434, WINTER

AUDIO VISUAL

SPRINGS, FL 32708 CITY OF WINTER **SPRINGS**

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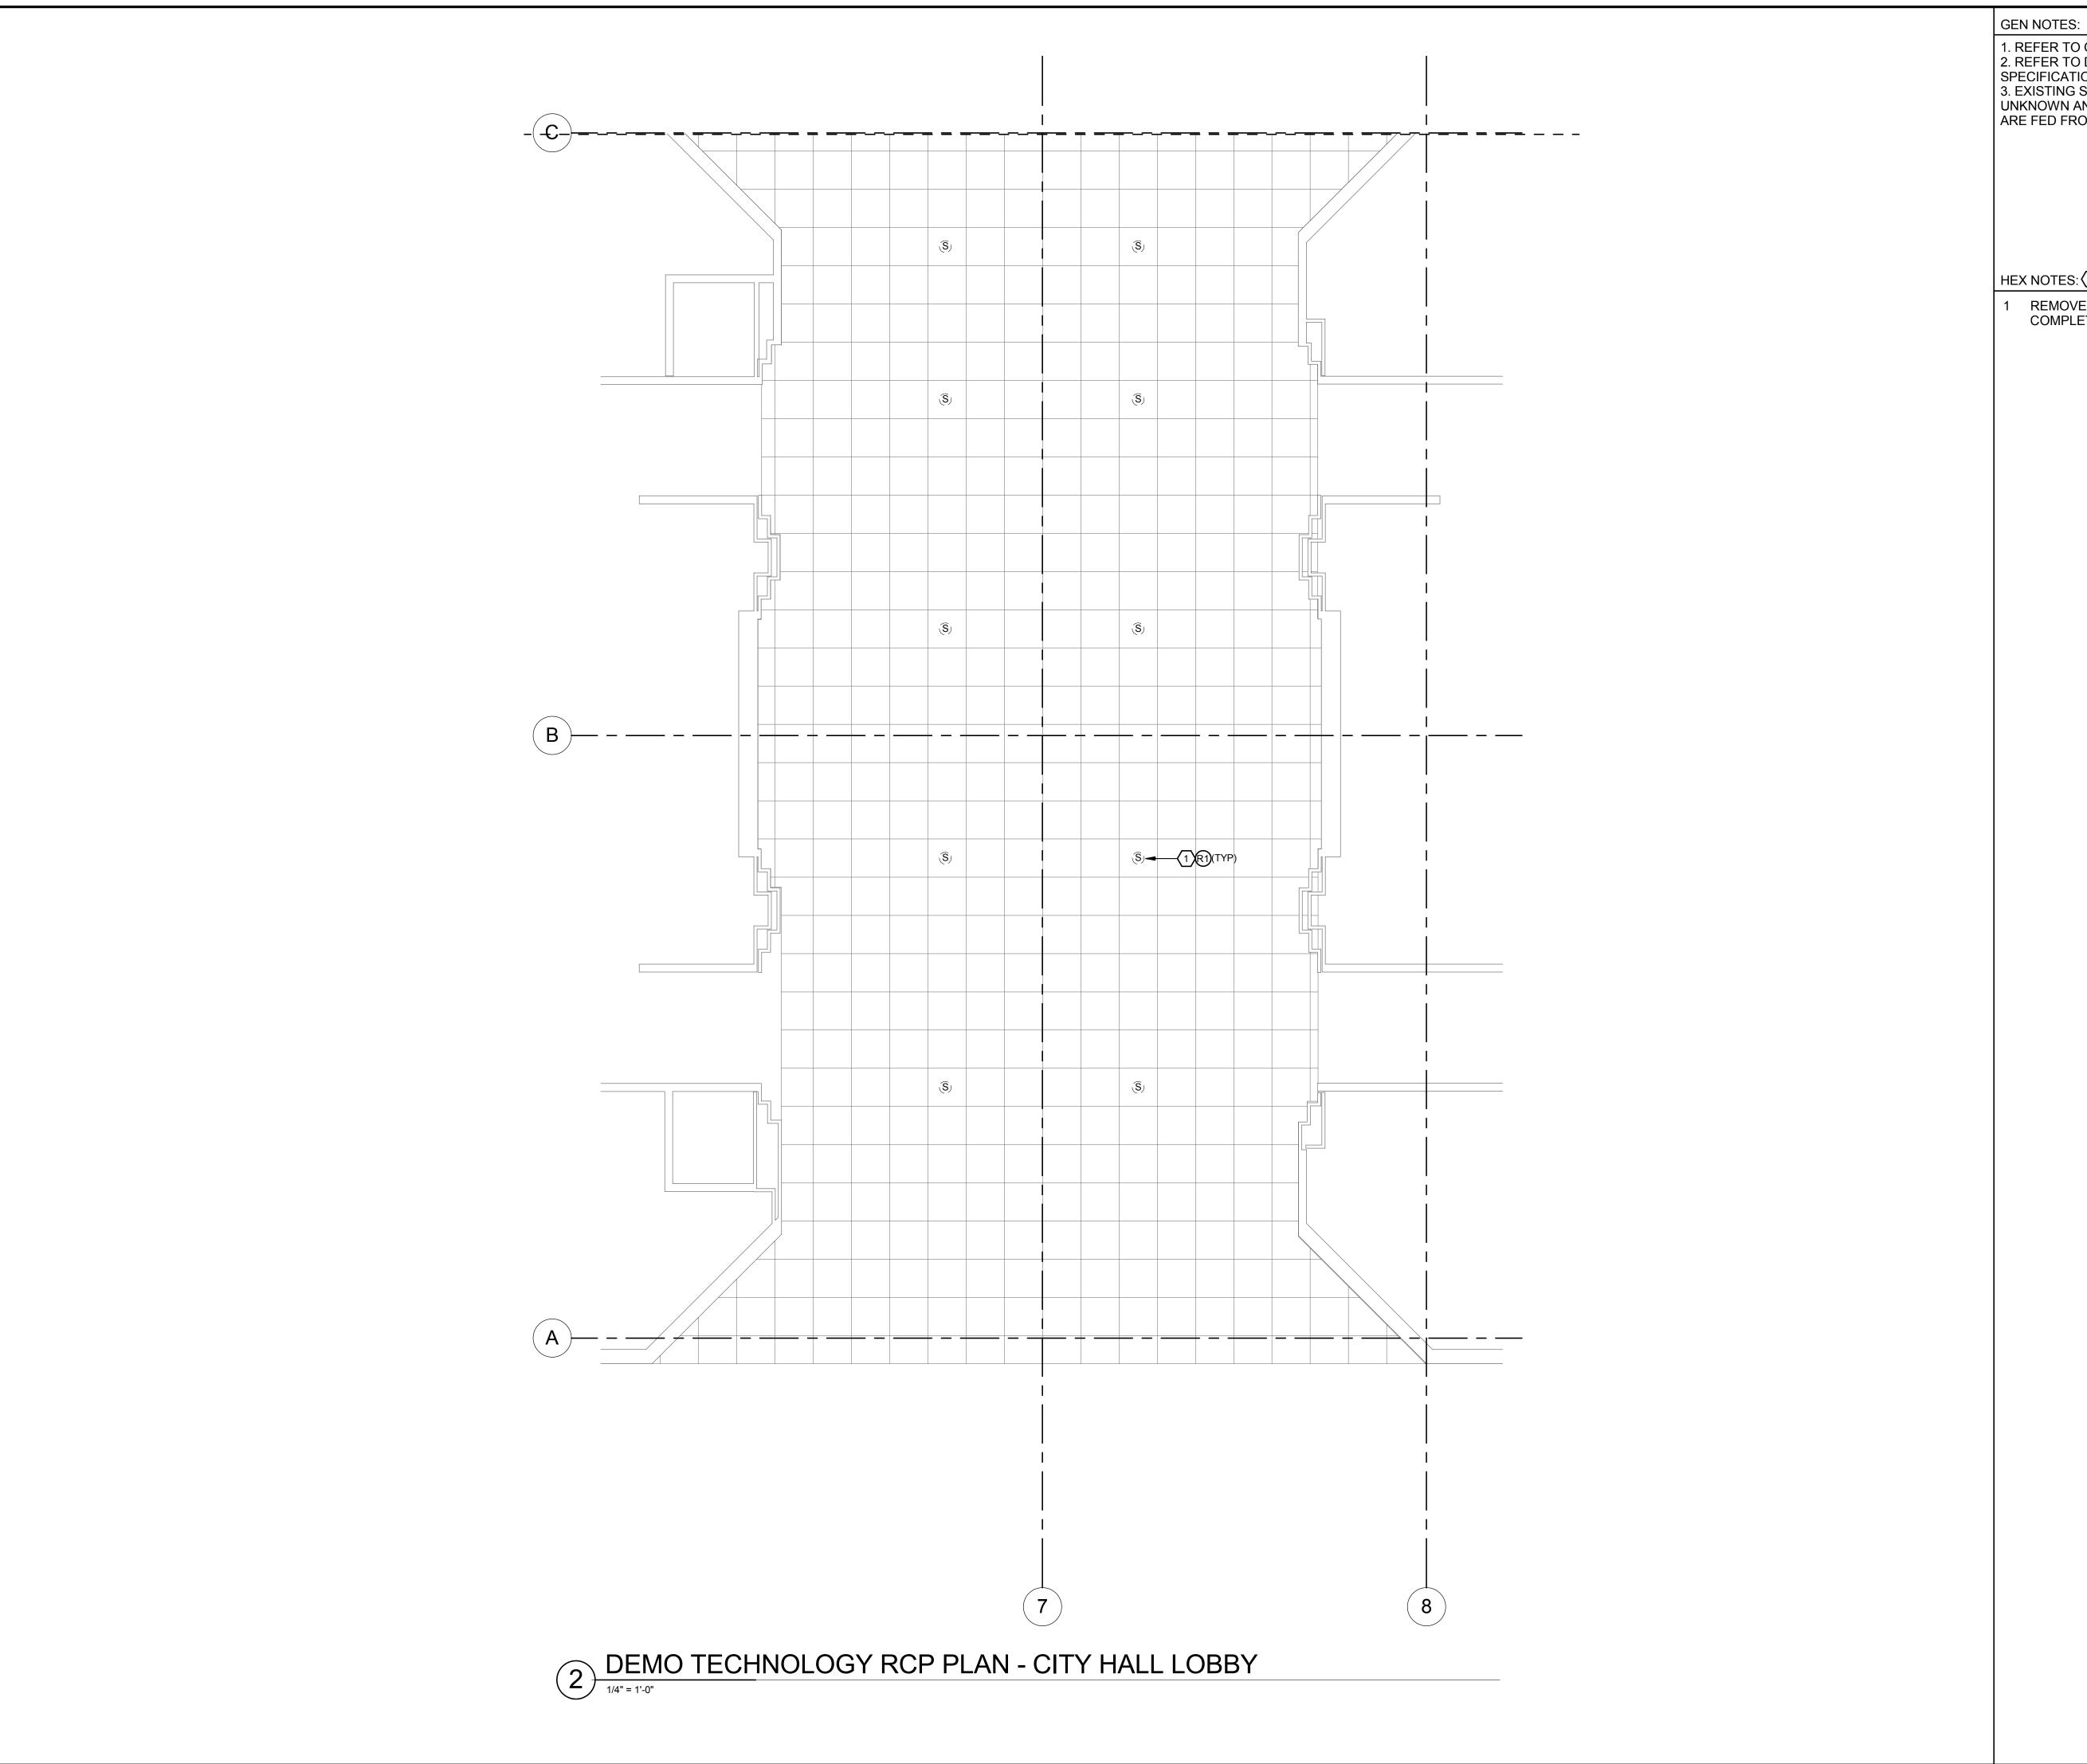
Professional Seal

No. Description Date

DEMO **TECHNOLOGY** FLOOR/CEILING PLAN - CITY HALL CHAMBERS

2017-090 Project Number DAM/RS Designed By Drawn By Checked By 1/4" = 1'-0" 7/14/2017 90% SUBMITTAL Project Status

ED-301



1. REFER TO GENERAL NOTES AND LEGENDS
2. REFER TO DETAIL, RISER DIAGRAMS, AND
SPECIFICATIONS SPECIFICATIONS

3. EXISTING SPEAKER CIRCUITING IS UNKNOWN AND SHALL REMAIN ALL SPEAKERS ARE FED FROM AMPS IN AV-01.

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HEX NOTES: ◯ BASE BID

1 REMOVE CEILING SPEAKER AND CABLE COMPLETE.

THE COMMISSION CHAMBER'S **AUDIO VISUAL** RENOVATION

1126 E STATE RD 434, WINTER SPRINGS, FL 32708 CITY OF WINTER SPRINGS

Approver

Professional Seal

No. Description Date

DEMO TECHNOLOGY CEILING PLAN -CITY HALL LOBBY

2017-090 Project Number DAM/RS Designed By Drawn By Checked By 1/4" = 1'-0" 7/14/2017 90% SUBMITTAL Project Status

ED-302